


Revisions:	By:

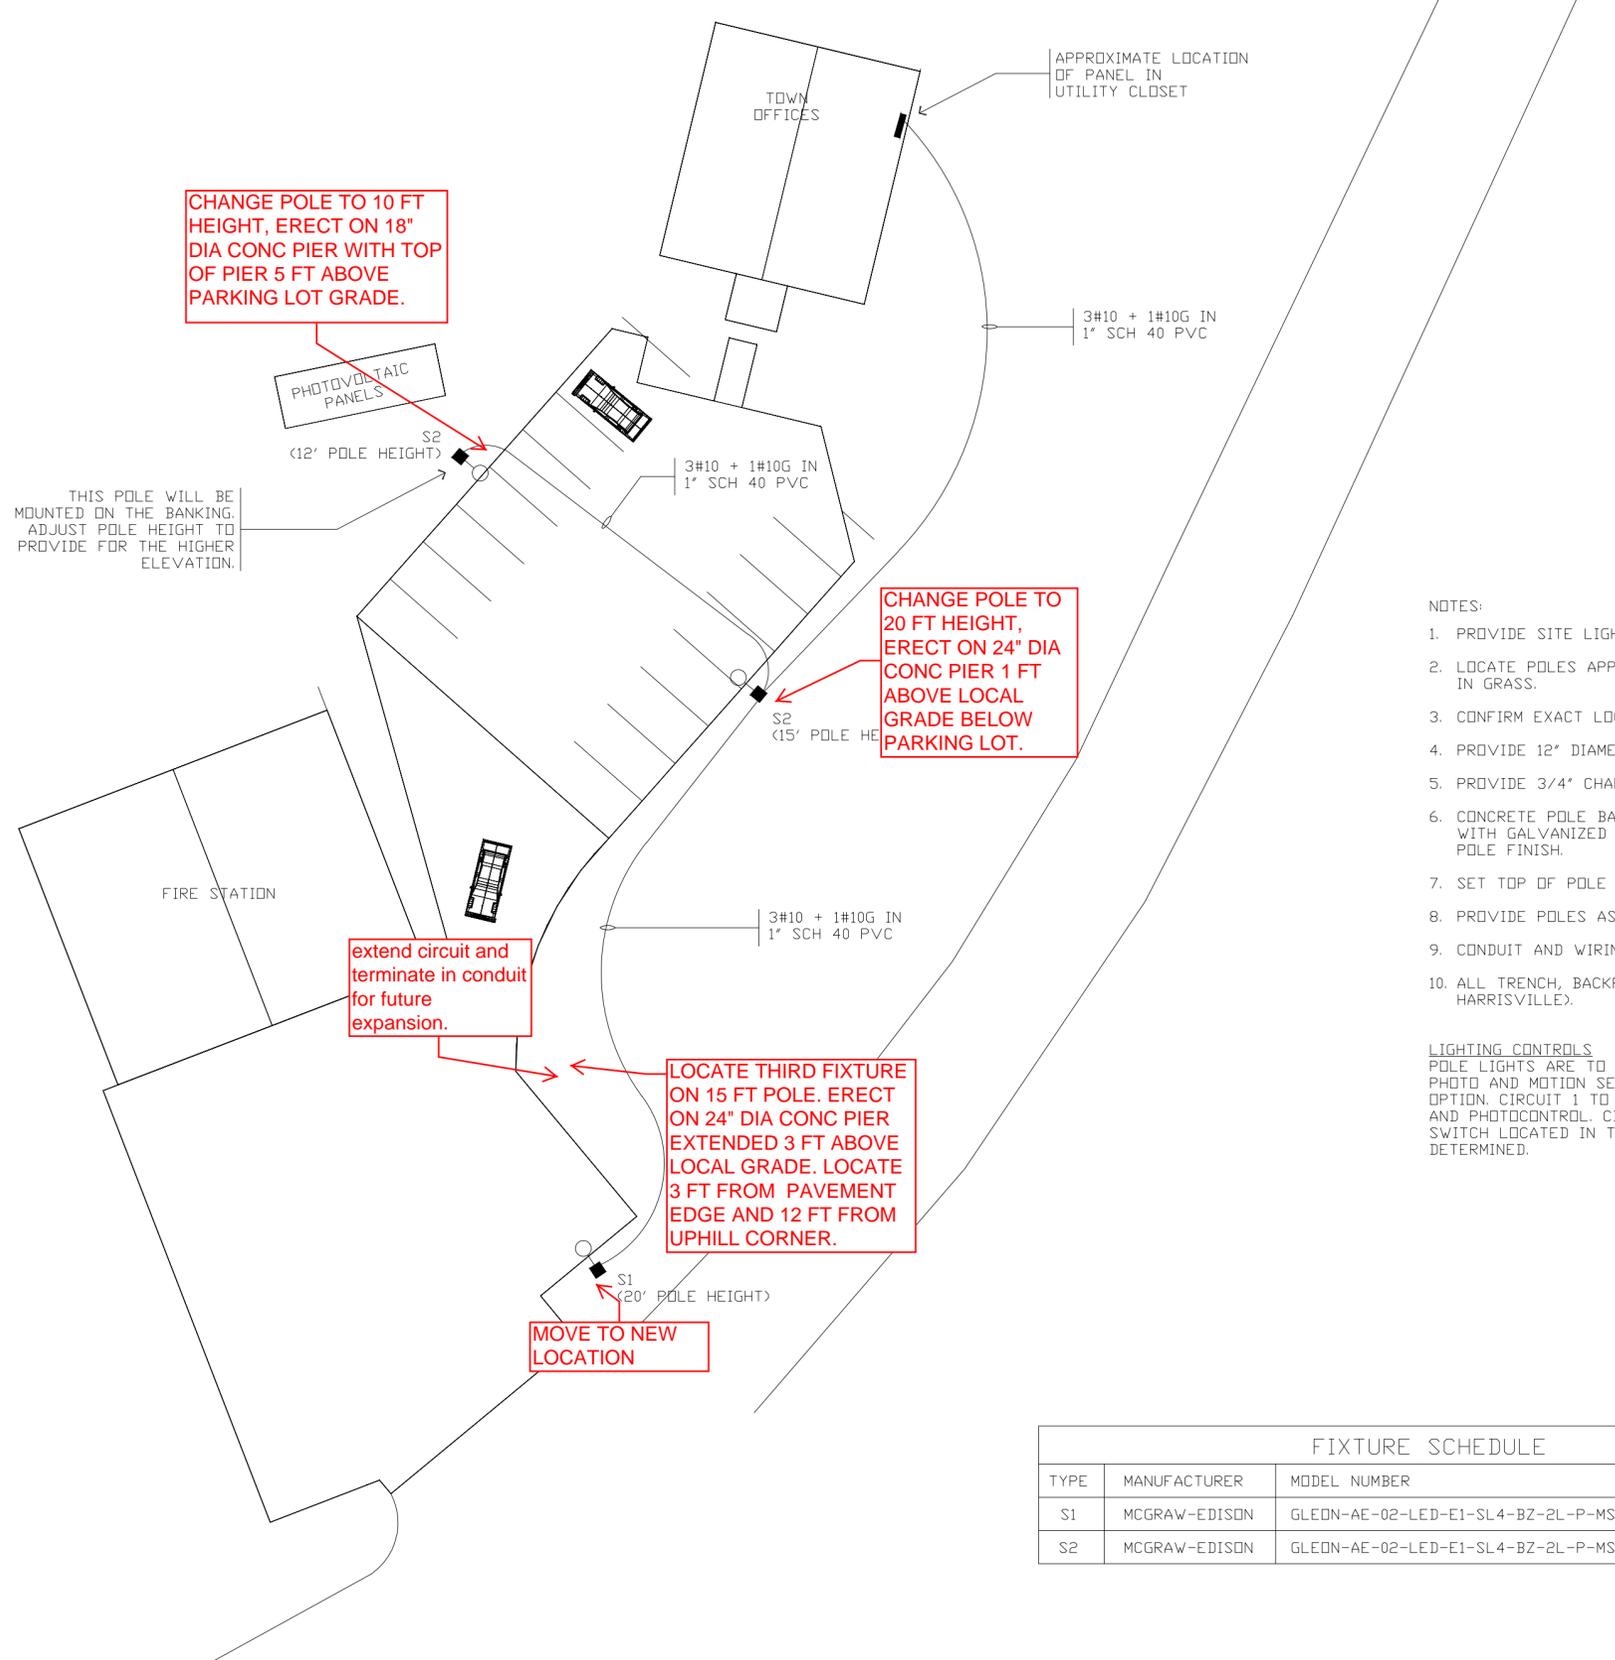

- NOTES:
1. PROVIDE SITE LIGHTING POLES MOUNTED ON CONCRETE POLE BASE.
 2. LOCATE POLES APPROXIMATELY 5' OFF THE EDGE OF PARKING LOT SIDE IN GRASS.
 3. CONFIRM EXACT LOCATION AND FIXTURE AIMING WITH OWNER.
 4. PROVIDE 12" DIAMETER CONCRETE POLE BASE WITH REINFORCING.
 5. PROVIDE 3/4" CHAMFER ALL AROUND WITH SMOOTH FINISH.
 6. CONCRETE POLE BASE SHALL EXTEND TO 5'-0" BELOW FINISHED GRADE WITH GALVANIZED ANCHOR BOLTS AND POLE BASE COVER TO MATCH POLE FINISH.
 7. SET TOP OF POLE CONCRETE POLE BASE 4" ABOVE FINISHED GRADE.
 8. PROVIDE POLES AS SCHEDULED.
 9. CONDUIT AND WIRING BURIED 24" BELOW FINISHED GRADE.
 10. ALL TRENCH, BACKFILL, AND PAVEMENT PATCHING BY OWNER (TOWN OF HARRISVILLE).

LIGHTING CONTROLS
 POLE LIGHTS ARE TO BE FURNISHED WITH 2 LIGHT SQUARES, INTEGRAL PHOTO AND MOTION SENSORS, LIGHT SPILL CONTROLS, AND 2-CIRCUIT OPTION. CIRCUIT 1 TO BE ACTIVATED VIA THE INTEGRAL MOTION SENSOR AND PHOTOCONTROL. CIRCUIT 2 IN ALL 3 POLES TO BE CONTROLLED VIA SWITCH LOCATED IN THE TOWN OFFICES, LOCATION TO BE FIELD DETERMINED.

FIXTURE SCHEDULE		
TYPE	MANUFACTURER	MODEL NUMBER
S1	MCGRAW-EDISON	GLEDN-AE-02-LED-E1-SL4-BZ-2L-P-MS/X-L20-HSS/SSS4A20SF
S2	MCGRAW-EDISON	GLEDN-AE-02-LED-E1-SL4-BZ-2L-P-MS/X-L20-HSS/SSS4A15SF

SITE PLAN - LIGHTING
 SCALE: 1" = 30'-0"

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 TELEPHONE 603/827-3672

TOWN OFFICE PARKING LOT
 NEW LIGHTING

Date: **REV 9/16/14**
 Scale: 1" = 30'
 Drawn: GJD
 Job:
 Sheet Number:
E-1
 Total sheet count: